
CONSULTING GROUP, INC.

Building 3000 Floor 5

Site Plan

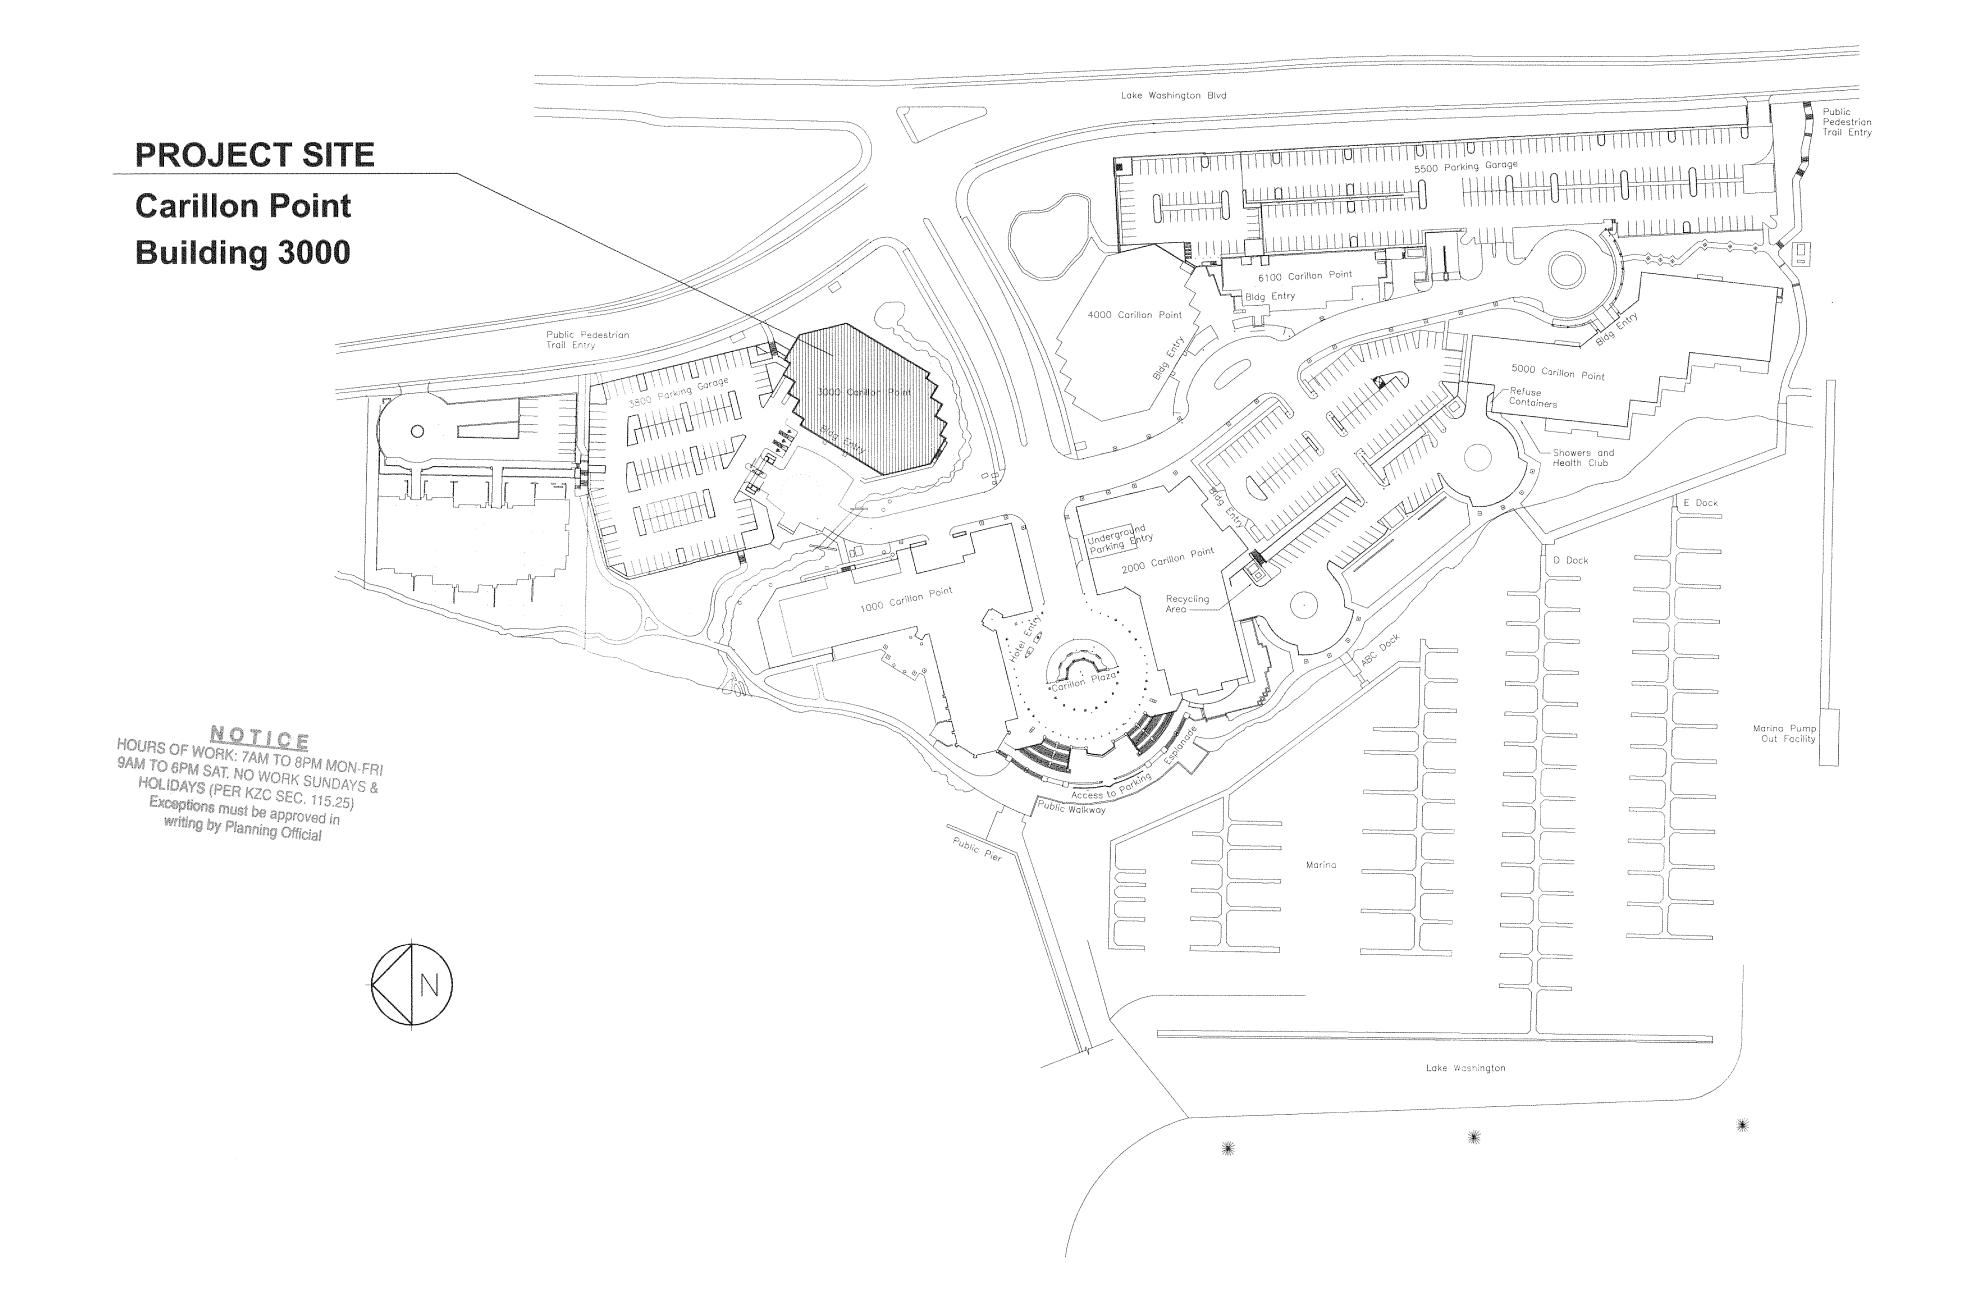

Sheet List Table

Sheet Number Sheet Title
1-0.0 Cover Sheet General Notes & Symbols Code Summary 1-1.5Demolition Plan Floor Plan

Reflected Ceiling Plan 1-6.5Finish Plan & Finish Specifications

Construction Details & Elevations

Code Information:

PROJECT ADDRESS: APPLICABLE EDITIONS OF BUILDING CODES: CarillonPoint Building Code 2009 INTERNATIONAL BLDG CODE (IBC), 3500 Carillon Point Kirkland, WA 98033 2009 INTERNATIONAL FIRE CODE (IFC), INCL. APPENDIX B&C CONSTRUCTION TYPE: Energy Code 2009 WASHINGTON STATE ENERGY CODE TYPE - 1A, FULLY SPRINKLERED (WSEC), WAC 51-11 2009 INTERNATIONAL MECHANICAL CODE (IMC), PLA-15A COMMERCIAL JUNE 22, 2009 WA CITIES ELECTRICAL CODE, PARTS 1 & 3 AS PUBLISHED BY WA ASSOC. OCCUPANCY: B BUSINESS TENANT SQUARE FOOTAGE: 2009 UNIFORM PLUMBING CODE (UPC), WAC 51-56 & 51-57 INCL. APPENDIX CHAPTERS H (area of work) 1,536 SF & L - EXCL. SECTIONS L5-L7 & "LAWN SPRINKLER HEAD" FROM TABLE 6-4 OF APPENDIX L ELECTRICAL, MECHANICAL, PLUMBING & FIRE PERMITS TO BE DEFERRED SUBMITTAL.


Zoning Code CITY OF KIRKLAND ZONING CODE Accessibility 2003 ACCESSIBLE & USABLE BUILDINGS & FACILITIES (ICC/ANSI A117.1) WAC 51-50-005

Legal Description:

TAX PARCEL #: 172505-9058

POR GL 1 & 2 & BLKS F & G OF THE 2ND SUPL PLAT OF LK WN SH LDS TGW 2ND CL SHLDS ADJ ALL LY WLY OF W MGN LK WN BLVD-LESS POR N OF S LN OF N 1076.80 FT SD GL 1 & ITS WLY PROD - LESS POR THOF S OF LN BEG AT NXN 1902.66 FT S & PLW N LN GL 1 & W MGN LK WN BLVD TH S 03-09-13 E ALG W MGN 75 FT TO TPOB OF DESC LN TH N 88-35-53 W TO INNER HARBOR LN & TERMINUS THIS LN - LESS POR CONV BY REC 8907281497 AKA LOT B KK ALT LL #LL-91-50 REC 9104302101

Vicinity Map:

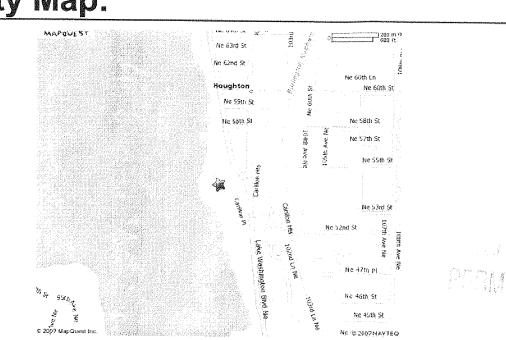

Project Team:


Property Manager: CARILLON PROPERTIES 4100 CARILLON POINT KIRKLAND, WA 98033

TEL: 425-822-1700 FAX: 425-828-3094 KURT MILLER kurt@carillonprop.com Architect:

JPC ARCHITECTS, PLLC 909 112TH AVE NE SUITE 206 BELLEVUE, WA 98004 (425) 641-9200

> AMY NICHOLS amyn@jpcarchitects.com

General Contractor:

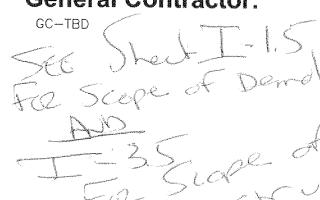

Cover Sheet

04/27/12 Permit Set

XTREME

CONSULTING GROUP, INC.

Carillon Point B3000

3500 Carillon Point

Kirkland, WA 98033

SG/AN

CP/AN

12-0309

Floor 5

DESIGN

DRAWN

NO.

CHECKED

1-0.0

DEVICES INCLUDING SPRINKLERS, SMOKE DETECTORS, FIRE EXTINGUISHERS AND HOSE

23. ANY CHANGE IN LIGHT FIXTURE PLACEMENT DUE TO INTERFERENCE OF MECHANICAL OR

24. ALL PERMITS INCLUDING FIRE, MECHANICAL, AND ELECTRICAL TO BE FILED SEPARATELY

STRUCTURAL COMPONENTS MUST BE APPROVED BY THE ARCHITECT.

CABINETS, PLUMBING AND PLUMBING EQUIPMENT.

VWC

VINYL WALL COVERING

WEST/WIDE

WOOD

WITHOUT WEIGHT

25. ALL GYPSUM BOARD PARTITIONS SHALL BE TAPED, SPACKLED AND SANDED SMOOTH WITH NO VISIBLE JOINTS. PATCH AND REPAIR SURFACES TO MATCH ADJACENT OR ADJOINING SURFACES WHERE REQUIRED. ALL SURFACES SHALL BE ALIGNED.

MODIFY EXISTING SUBSTRATE AS REQUIRED TO RECEIVE NEW FLOORING MATERIALS, THUS PREVENTING NOTICEABLE LUMPS OR DEPRESSIONS.

27. ALL WORK SHALL BE ERECTED AND INSTALLED PLUMB, LEVEL, SQUARE AND TRUE.

28. REFER TO MILLWORK SHOP DRAWINGS FOR SPECIFIC DETAILS OF COORDINATION BETWEEN

29. ALL GLASS SHALL BE CLEAR TEMPERED GLASS, UNLESS OTHERWISE NOTED, GLAZING TONG MARKS SHALL NOT BE VISIBLE. CLEAN AND POLISH ALL GLASS PRIOR TO PROJECT DELIVERY.

DRYWALL/MILLWORK CONDITIONS.

ALL MILLWORK TO BE FASTENED TO THE PARTITION, PROVIDE NON-COMBUSTIBLE BLOCKING FOR ALL MILLWORK NOT SUPPORTED BY FLOOR OR ABOVE 4'-0" HT. ALL CONCEALED LUMBER & BLOCKING TO BE FIRE TREATED.

31. CONTRACTOR TO PROVIDE SHOP DRAWINGS FOR: HVAC, CARPET SEAMING, LIGHTING,

MOISTURE TEST — REQUIRED FOR ALL ON GRADE SLAB CONDITIONS DURING THE CONSTRUCTION ESTIMATING/BUDGETING PROCESS THE GENERAL CONTRACTOR SHALL BE RESPONSIBLE FOR OBTAINING FROM THE BUILDING OWNER DOCUMENTATION AS TO THE VAPOR EMISSIONS RATE (MOISTURE TEST) FOR ALL "ON GRADE SLAB CONDITIONS". THIS INFORMATION SHOULD THEN BE IMMEDIATELY SHARED BETWEEN THE ARCHITECT, THE ARCHITECTS' SELECTED FLOORING REPRESENTATIVE(S), AND FLOORING SUB-CONTRACTOR FOR REVIEW AND APPROVAL OF APPLICABLE MATERIALS AND ANCILLARY INSTALLATION/FINISH PRODUCTS. IF NO MOISTURE TEST CAN BE FURNISHED OR IF FINDING ARE IN QUESTION THE GENERAL CONTRACTOR SHALL PERFORM THE FOLLOWING

A. PROVIDE (3) CALCIUM CHLORIDE MOISTURE TESTS FOR THE FIRST THOUSAND SQUARE FEET AND (1) TEST FOR EVERY ONE THOUSAND SQUARE FEET THEREAFTER AT ALL FLOORS WITHIN SCOPE OF WORK. THE CALCIUM CHLORIDE TEST SHALL BE CONDUCTED IN ACCORDANCE WITH THE LATEST EDITION OF ASTM F 1869 "STANDARD TEST METHOD" FOR MEASURING VAPOR EMISSIONS RATE OF CONCRETE SUN-FLOOR USING ANHYDROUS CALCIUM CHLORIDE. PROVIDE A WRITTEN REPORT OF FINDINGS TO THE ARCHITECT AS NOTED ABOVE.

B. PROVIDE A PH PENCIL TEST AT ALL FLOORS WITHIN SCOPE OF WORK, PROVIDE A WRITTEN REPORT OF FINDINGS TO THE ARCHITECT AS NOTED ABOVE.

IF REQUIRED BY THE CALCIUM CHLORIDE TEST, A WATERPROOF MEMBRANE SHALL BE APPLIED TO ALL FLOORS WITHIN THE SCOPE OF WORK. THE WATERPROOF MEMBRANE(S) SHALL BE APPROPRIATED FOR EACH FINISH FLOORING APPLICATION AS SPECIFIED BY THE SPECIFIC FLOORING MANUFACTURER VIA THE ARCHITECT. A LICENSED INSTALLER SHALL BE UTILIZED FOR INSTALLATION/APPLICATION OF EACH SPECIFIC MEMBRANE (AS APPLICABLE TO THE FINISH FLOORING PRODUCT) AND A WRITTEN WARRANTY SHALL BE PROVIDED DOCUMENTING STRICT CONFORMANCE TO THE SPECIFIED MANUFACTURES INSTALLATION REQUIREMENTS TO ENSURE AND UPHOLD ALL PERFORMANCE AND LIFE CYCLE GUARANTEES.

33. CONCRETE SLAB ON GRADE REPAIR — MINOR SCOPE (100 SQUARE FEET OR LESS)

WHERE CONCRETE SLAB ON GRADE INFILL AND TRENCHING MUST OCCUR; CONDUCT THE APPROPRIATE UNDER SLAB INVESTIGATION (VIA SONO-GRAPH AND/OR X-RAY) TO LOCATE EXISTING UTILITIES OR OTHER OBSTRUCTIONS THAT SHOULD NOT BE DAMAGED. SAW CUT SLAB AT SUBJECT AREA(S) AND PULL BACK THE EXISTING VAPOR BARRIER (IF PRESENT) AND PROTECT FOR FUTURE RE-INSTALLATION. EXECUTE THE NECESSARY UNDER SLAB WORK (INCLUDING EXCAVATION), BACKFILL AND RE-COMPACT THE SUBJECT AREA WITH THE PREVIOUSLY HELD MATERIALS (IF THE EXCAVATED MATERIALS ARE NOT SUITABLE FOR RE-INSTALLATION, DISCARD AND PROVIDE NEW FREE DRAINING GRANULAR MATERIAL). RE-COMPACT FILL SOIL TO AT LEAST 95% OF THE MAXIMUM DRY DENSITY (MDD) OBTAINED IN GENERAL ACCORDANCE WITH THE ASTM D 1557 TEST PROCEDURE. RE-INSTALL THE EXISTING VAPOR BARRIER AND BIND SEAMS WITH MINIMUM 3" WIDE PRESSURE SENSITIVE TAPE TO ENSURE AN AIR/MOISTURE RESISTANT BOND. ATTACH NEW INFILL TO EXISTING CONCRETE SLAB WITH 18 INCH LONG #4 REBAR AT 24 INCHES ON CENTER EMBEDDED 8 INCHES INTO THE EXISTING CONCRETE SLAB WITH HILTI HY-150 ADHESIVE (OR SIMPSON SET ADHESIVE). REINFORCEMENT SHALL BE INSTALLED PER ADHESIVE MANUFACTURER'S RECOMMENDATIONS. PROVIDE W2 X W2 X 6 X 6 WELDED WIRE FABRIC WITHIN SUBJECT AREA(S), INFILL SLAB TO MATCH THICKNESS OF ADJACENT SURFACE(S) (BUT NOT BE LESS THAN FOUR INCHES THICK) AND #4 DOWELS SHALL BE CENTERED IN SLAB. THE CONCRETE SHALL HAVE A MINIMUM 28 DAY COMPRESSIVE STRENGTH OF 3000 PSI WITH A MAXIMUM WATER CEMENT RATION OF 0.58 AND IS TO BE PLACED LEVEL WITH ADJACENT SURFACES. LET CURE AND PROVIDE MOISTURE TESTING AS SPECIFIED ABOVE.

IF SCOPE OF WORK INCLUDES STRUCTURAL ELEVATED SLABS CONSULT A STRUCTURAL ENGINEER, REFER TO STRUCTURAL PLANS, IF APPLICABLE, FOR ADDITIONAL SPECIFICATIONS AND REQUIREMENTS.

34. CLEAN, REPAIR ANY EXISTING PERIMETER BLINDS AS REQUIRED TO BE IN A FULLY FUNCTIONING & OPERATIONAL MANNER.

35. COORDINATE WITH SUB-CONTRACTORS THE LOCATIONS OF ELECTRICAL AND VOICE/DATA OUTLETS, PLUMBING AND OTHER DEVICES WITH LAYOUT AND DESIGN OF CUSTOM

 $\frac{5}{(1-10.3)}$ DETAIL REFERENCE BUBBLE

(REFER TO SHEET/KEY NOTES)

JOB NORTH

CUSTOM CASEWORK SHALL CONFORM TO A.W.I. STANDARDS FOR CUSTOM GRADE FABRICATION.

Symbol Legend:

2306 ROOM NUMBER REFERENCE

(2306) DOOR NUMBER REFERENCE.

(1-10.3) INTERIOR ELEVATION SYMBOL

REVISION REFERENCE

Demolition Notes:

- OBTAIN DEMOLITION PERMITS AND INCLUDE ALL COSTS OF SAME IN CONTRACT PRICE.
- FURNISH ALL LABOR AND MATERIALS/EQUIPMENT TO COMPLETE DEMOLITION AND REMOVAL OF ALL ITEMS AS INDICATED.
- CONTRACTOR SHALL KEEP CONSTRUCTION AREA FREE OF DUST AND DEBRIS FOR THE DURATION OF CONSTRUCTION.
- IF ANY QUESTIONS ARISE AS TO THE REMOVAL OF ANY MATERIAL, CLARIFY THE POINT IN QUESTION WITH THE ARCHITECT BEFORE PROCEEDING.
- AT COMPLETION OF DEMOLITION WORK, THE CONSTRUCTION AREA(S) SHALL BE LEFT IN "BROOM CLEAN" CONDITION. ALL DEBRIS AND MISCELLANEOUS MATERIAL SHALL BE REMOVED.
- ALL DEBRIS REMOVAL SHALL BE PERFORMED IN ACCORDANCE WITH BUILDING MANAGEMENT REQUIREMENTS AND PROCEDURES.
- AS DIRECTED BY BUILDING MANAGEMENT, ALL DOORS, FRAMES, HARDWARE, MECHANICAL ITEMS, PLUMBING FIXTURES, LIGHT FIXTURES (INCLUDING DOWNLIGHTS AND FLUORESCENTS), AND SPECIAL EQUIPMENT SHOWN TO BE REMOVED, SHALL BE CLEAN AND FREE OF DEFECTS. PROTECTED, SAVED AND REUSED AS DIRECTED HEREIN, OR RETURNED TO BUILDING STOCK.
- IN PARTITIONS TO BE REMOVED, REMOVE AND CAP ALL OUTLETS, SWITCHES, WIRES, THERMOSTATS, ETC., TO THEIR SOURCE.
- CONTRACTOR SHALL BE RESPONSIBLE FOR PATCHING AND/OR REPAIRING ANY DAMAGE CAUSED BY HIM OR HIS SUBCONTRACTORS TO EXISTING CONSTRUCTION IN ELEVATOR LOBBY, PUBLIC CORRIDORS, RESTROOMS OR TENANT SPACES. REFINISH TO MATCH EXISTING ADJACENT FINISH, OR AS NOTED HEREIN.
- NO EXISTING SMOKE DETECTOR, PUBLIC ADDRESS SPEAKER, FIRE ALARM BOX OR SIMILAR DEVICE, INCLUDING THE ASSOCIATED WIRING SHALL BE DAMAGED DURING DEMOLITION AND SUBSEQUENT CONSTRUCTION. RELOCATION OF SMOKE DETECTORS, PUBLIC ADDRESS SPEAKERS AND FIRE ALARM EQUIPMENT, NECESSITATED BY NEW CONSTRUCTION, SHALL BE ACCOMPLISHED AS A FIRST PRIORITY, AND PER THE PLANS. NO ACTIVE SMOKE DETECTOR SHALL BE COVERED OR OTHERWISE REMOVED OR USED FOR OTHER THAN IT'S INTENDED
- REMOVAL OF ANY EQUIPMENT, CABLING SWITCHES, AND CONDUIT PERTAINING TO DATA/COMMUNICATIONS AND TELEPHONE SHALL BE VERIFIED WITH TELEPHONE COMPANIES AND TENANT.

PURPOSE.

Dimension Notes:

FINISHES, U.N.O.

INSTALLATION.

SAME PLANE.

CLOSING OUT PARTITIONS.

- REMOVE ALL EXISTING MATERIALS WHICH WOULD CAUSE RISES OR DEPRESSIONS IN NEW FLOORING SURFACE, SUCH AS FASTENERS. OUTLET CORES, COVER PLATES, RESILIENT FLOOR COVERINGS, CARPET, CARPET PAD, FLASH PATCH, CONCRETE FILL, PLYWOOD, ETC.
- 3. DEMOLITION IS NOT NECESSARILY LIMITED TO WHAT IS SHOWN ON DRAWINGS. THE INTENT IS TO INDICATE THE GENERAL SCOPE OF DEMOLITION REQUIRED TO COMPLETE THE WORK IN ACCORDANCE WITH THE CONTRACT DRAWINGS.
- RATED WALLS SHALL NOT BE PENETRATED UNLESS THE RATING IS MAINTAINED.

DO NOT SCALE DRAWINGS, WRITTEN DIMENSIONS GOVERN. ALL

TAKES PRECEDENCE OVER ALL OTHER PLANS.

WRITTEN INSTRUCTION FROM ARCHITECT.

ARCHITECT. SECURE ARCHITECT'S APPROVAL.

AND PLENUM BARRIER LOCATIONS.

PARTITION LOCATIONS SHALL BE AS SHOWN ON PARTITION PLAN. IN

CASE OF CONFLICT NOTIFY ARCHITECT. PARTITION PLAN BY ARCHITECT

ALL PARTITIONS ARE DIMENSIONED FROM FINISH FACE OF GYPSUM

BOARD TO FINISH FACE OF GYPSUM BOARD UNLESS OTHERWISE

NOTED. ALL DIMENSIONS MARKED "CLEAR" OR "CLR" SHALL BE

MAINTAINED AND SHALL ALLOW FOR THICKNESSES OF ALL WALL

DIMENSIONS NOTED "CLEAR" OR "CLR" MUST BE ACCURATELY

MAINTAINED, AND SHALL NOT VARY MORE THAN \pm 1/8" WITHOUT

DIMENSIONS MARKED ± MEAN A TOLFRANCE NOT GREATER NOR

NOTIFY ARCHITECT IN WRITING OF ANY DISCREPANCIES OR CONFLICTS

IN THE LOCATION(S) OF NEW CONSTRUCTION. UPON COMPLETION OF

PARTITION LAYOUT, NOTIFY ARCHITECT. VERIFICATION OF THE LAYOUT

REFER TO REFLECTED CEILING PLANS FOR SOFFITS, CEILING HEIGHTS

DIMENSIONS LOCATING DOORS ARE TO THE INSIDE EDGE OF JAMB.

B. "ALIGN" MEANS TO ACCURATELY LOCATE FINISHED FACES IN THE

). ALL DOORS SHALL HAVE 1'-6" CLR. ON STRIKE/PULL SIDE OF

DOOR. VERIFY AND ADVISE ARCHITECT OF EXCEPTIONS PRIOR TO

SMALLER THAN 2 INCHES FROM INDICATED DIMENSION, U.N.O.

VERIFY FIELD DIMENSIONS EXCEEDING TOLERANCE WITH THE

TO BE PROVIDED BY THE ARCHITECT PRIOR TO PARTITION

ALL EXISTING OUTLETS UNAFFECTED BY CONSTRUCTION ARE TO REMAIN AND ARE TO BE INTEGRATED INTO THE CURRENT SCHEME WHERE POSSIBLE.

FURNISH AND INSTALL ALL FIXTURES, ASSOCIATED TRIM AND FIXTURE

LAMPS AS REQUIRED. ONLY NEW OUTLETS /FIXTURES ARE SHOWN.

Electrical Notes:

- SURVEY FIELD CONDITIONS AND VERIFY THAT WORK IS FEASIBLE AS SHOWN. VERIFY LOCATION OF ALL OUTLETS IN RELATION TO STRUCTURAL AND OTHER ELEMENTS AS REQUIRED. NOTIFY ARCHITECT IN WRITING OF ANY DISCREPANCIES BEFORE PROCEEDING WITH WORK.
- ARCHITECTURAL DRAWINGS DETERMINE LOCATION AND TYPE (ARCHITECT TO VERIFY W/ ENGINEER) OF ALL OUTLETS AND TAKE PRECEDENCE OVER ALL OTHERS. U.N.O.. ELECTRICAL ENGINEER'S POWER PLAN SHALL GOVERN THE WIRING LAYOUT AND INSTALLATION IN COMPLIANCE WITH ALL LAWS APPLICABLE AND ENFORCED BY GOVERNING AUTHORITIES.
- OUTLETS SHOWN BACK TO BACK ON PARTITION WALLS SHALL BE OFFSET 1'-0", MAXIMUM, OR MOUNTED AT DIFFERENT HEIGHTS IF
- FURNITURE, IF SHOWN, IS FOR REFERENCE ONLY AND IS NOT IN CONTRACT, U.N.O.
- COORDINATE ALL WORK RELATED TO EQUIPMENT WITH MANUFACTURER'S RECOMMENDATIONS, SPECIFICATIONS AND INSTRUCTIONS.
- ALL EXISTING AND NEW FLOOR SLAB PENETRATIONS FOR CONDUIT OR PLUMBING LINES SHALL BE FULLY PACKED & SEALED IN ACCORDANCE WITH THE APPLICABLE BUILDING AND FIRE CODES.
- COORDINATE NEW ELECTRICAL WITH EXISTING, WHERE OCCURS.
- UPON COMPLETION OF OUTLET LAYOUT, NOTIFY THE ARCHITECT. ARCHITECT SHALL SITE VERIFY ALL OUTLET LOCATIONS PRIOR TO COMMENCEMENT OF CORING OR OUTLET INSTALLATION.
- . FURNISH AND INSTALL ONLY UNDERWRITERS LABORATORIES, INC. (UL) LABELLED DEVICES THROUGHOUT.
- INSTALL WALL MOUNTED OUTLETS 18 INCHES ABOVE FINISHED FLOOR, U.N.O. HEIGHTS SHALL BE DETERMINED FROM FINISHED FLOOR TO THE CENTERLINE OF COVERPLATE, INSTALLED VERTICALLY, GROUNDING POLE AT BOTTOM, U.N.O.
- MAINTAIN A 4-INCH HORIZONTAL CLEARANCE IN ALL DIRECTIONS, MIN. FROM EDGE OF COVERPLATE, FOR WALL MOUNTED OUTLETS, OR FROM EDGE OF MONUMENT FOR FLOOR MOUNTED OUTLETS, WHEN ADJACENT TO A WALL, COLUMN, OR SIMILAR ELEMENTS, U.N.O.

INDICATED DIMENSIONS ARE TO THE CENTER OF THE COVERPLATE OR

- MONUMENT; CLUSTERS OF OUTLETS ARE DIMENSIONED TO THE CENTER OF THE CLUSTER, U.N.O.; GANG COVERPLATES SHALL BE ONE-PIECE ELECTRICAL SWITCH AND OUTLET COVER PLATES, SURFACE HARDWARE,
- ETC. SHALL BE INSTALLED AFTER PAINTING AND/OR APPLICATION OF WALLCOVERINGS & CARPET SPECIFIED. POWER/DATA/TELEPHONE REQUIREMENTS FOR OPEN OFFICE
- DRAWINGS-BY OTHERS. 16. THE FURNITURE ELECTRICAL IS AN 8-WIRE SYSTEM. ALL ELECTRICAL FEEDS TO ANY OF THE PRODUCT MUST BE IN AN 8-WIRE

WORKSTATIONS TO BE PROVIDED WITH FURNITURE INSTALLATION

- 17. "H" INDICATES THAT AN OUTLET SHALL BE MOUNTED HORIZONTALLY.
- 18. VERIFY NEW FLUSH FLOOR OUTLET LOCATIONS WITH FURNITURE LAYOUT | 16. ALL SMOKE DAMPERS SHALL BE INSTALLED IN ACCORDANCE WITH PRIOR TO INSTALLATION.
- 19. ALL SWITCHES AND DIMMERS SHALL BE LOCATED 46" ABOVE FINISHED FLOOR TO CENTER OF SWITCH U.O.N., MULTIPLE SWITCHES AT ONE LOCATION SHALL BE GANGED TOGETHER AND FINISHED WITH ONE COVER PLATE U.N.O.

OUTLET FINISHES: ISOLATED GROUND- GRAY UPS- ORANGE ALL OTHERS- MATCH BUILDING STANDARD SWITCH FINISH: MATCH BUILDING STANDARD OVERPLATE FINISH: MATCH BUILDING STANDARD (INCLUDES ALL COVERPLATES—POWER/VOICE/DATA)

Door Notes:

CONFIGURATION

ALL EXIT DOORS SHALL BE OPERABLE FROM THE INSIDE WITHOUT THE USE OF KEY OR ANY SPECIAL KNOWLEDGE OR EFFORT.

- ALL GLAZING SHALL CONFORM TO SAFETY GLAZING REQUIREMENTS OF IBC SECTION 2406.
- MAGNETIC HOLD OPEN DEVICES SHALL BE TIED TO BUILDING FIRE ALARM SYSTEM.
- ALL RATED DOORS TO BE LABELED PER IBC TABLE 715.3.
- THRESHOLDS AT DOORWAYS SHALL BE !" MAXIMUM IN HEIGHT. PER ICC/ANSI A117.1-2003 SECTION 404.2.4.
- ICC/ANSI A117.1-2003 SECTION 404.2.6. DOOR HARDWARE. HANDLES, PULLS, LATCHES, LOCKS & OTHER OPERABLE PARTS ON ACCESSIBLE DOORS SHALL HAVE A SHAPE THAT IS EACH TO GRASP WITH ONE HAND & DOES NOT REQUIRE TIGHT GRASPING, PINCHING, OR TWISTING OF THE WRIST TO OPERATE. OPERABLE PARTS OF SUCH HARDWARE SHALL BE 34" MIN. & 48" MAX. ABOVE THE FINISH FLOOR. WHERE SLIDING DOORS ARE IN THE FULLY OPEN POSITION. OPERATING HARDWARE SHALL BE EXPOSED & USABLE FROM BOTH SIDES.
- ICC/ANSI A117.1 2003 SECTION 404.2.8 DOOR OPENING FORCE. FIRE DOORS SHALL HAVE THE MINIMUM OPENING FORCE ALLOWABLE BY THE APPROPRIATE ADMINISTRATIVE AUTHORITY. THE MAXIMUM FORCE FOR PUSHING OPEN FOR PULLING OPEN DOORS OTHER THEN FIRE DOORS SHALL BE AS FOLLOWS: 1. INTERIOR HINGED DOOR: 5.0 POUNDS (22.2 N) 2. SLIDING OR FOLDING DOOR: 5.0 POUNDS (22.2 N). THESE FORCES DO NOT APPLY TO THE FORCE REQUIRED TO RETRACT LATCH BOLTS OR DISENGAGE OTHER DEVICES THAT HOLD THE DOOR IN A CLOSED POSITION.
- ACTIVATION OF THE BUILDING AUTOMATIC SPRINKLER OR FIRE DETECTION SYSTEM, IF PROVIDED, SHALL AUTOMATICALLY UNLOCK ALL ELECTRONICALLY SECURED DOORS WITH IN THE EGREE PATHWAY. THE DOORS SHALL REMAIN UNLOCKED UNTIL THE FIRE ALARM HAS BEEN
- ENTRANCE DOORS IN THE BUILDINGS WITH OCCUPANCY IN GROUP A. B. E OR M SHALL NOT BE SECURED FROM THE EGRESS SIDE DURING PERIODS THAT THE BUILDING IS OPEN TO THE GENERAL PUBLIC.

Reflected Ceiling Notes:

REQUIRED.

- COORDINATE THE WORK OF ALL TRADES INVOLVED IN THE CEILING WORK TO ENSURE CLEARANCES FOR FIXTURES, DUCTS, PIPING, CEILING SUSPENSION SYSTEM, ETC., NECESSARY TO MAINTAIN THE FINISHED CEILING HEIGHTS INDICATED ON ARCHITECT'S DRAWINGS.
- PERIMETER CEILING ANGLE, WHERE OCCURS, SHALL BE INSTALLED TIGHT TO VERTICAL SURFACES, FREE FROM CURVES, BREAKS OR OTHER IRREGULARITIES AND PAINTED TO MATCH CEILING FINISH.
- FURNISH AND INSTALL ALL ASSOCIATED TRIM AND SEISMIC BRACING AS
- LIGHT FIXTURES, NEW SPRINKLERS AND OTHER CEILING ELEMENTS SHALL BE CENTERED IN THE 2'X2' SECTION OF INDIVIDUAL CEILING TILES U.N.O. (EXIST. SPRINKLERS TO REMAIN UNLESS CONFLICT WITH NEW ELEMENTS).
- PROVIDE CEILING ACCESS AS REQUIRED FOR EQUIPMENT AND SYSTEM MAINTENANCE, AND MATCH ADJACENT CEILING FINISH U.N.O.
- ALL SOFFITS AND CEILING HEIGHTS ARE DIMENSIONED FROM TOP OF FINISHED FLOOR TO BOTTOM OF FINISHED GYPSUM BOARD OR CEILING TILE AND SHALL ALLOW FOR THICKNESS OF ALL FLOOR FINISHES.
- THE REFLECTED CEILING PLAN INDICATES THE LOCATION OF CEILING HEIGHTS, LIGHT TYPES, LIGHT FIXTURES, AND ASSOCIATED ITEMS.
- ALL SPECIFIC INFORMATION CONCERNING INSTALLATION FOR VARIOUS ABOVE-CEILING ELEMENTS ARE TO BE DESIGN BUILD, DOCUMENTATION BY OTHERS - PERMITTED SEPARATELY.
- NOTIFY ARCHITECT OF ANY CONFLICTS OF LIGHT FIXTURE LOCATIONS WITH MAIN RUNNERS, DUCTS, STRUCTURES, HVAC, AND/OR (E)CONDUIT PRIOR TO FRAMING FOR LIGHTS. ANY DISCREPANCIES BETWEEN ARCHITECT'S CEILING GRID LOCATION & ACTUAL FIELD CONDITIONS ARE TO BE CLARIFIED WITH THE ARCHITECT PRIOR TO FRAMING.
- O. SUBMIT GRILLE, THERMOSTAT, AND OTHER FIXTURE AND ELEMENT LAYOUTS TO THE ARCHITECT FOR REVIEW AT LEAST 2 WEEKS PRIOR
- VERIFY FIELD CONDITIONS AND LOCATIONS OF ALL PLUMBING. MECHANICAL DUCTS, STRUCTURAL ELEMENTS AND ALL OTHER RELATED ITEMS. INSTALL NEW PLUMBING, MECHANICAL, FANS, DUCTS, CONDUITS, AND OTHER RELATED ITEMS SO AS TO NOT CONFLICT WITH ANY/ALL FIELD CONDITIONS INCLUDING LUMINAIRES.
- INSTALL NEW LIGHT FIXTURES WITH PROTECTIVE FILM OR SIMILAR COVE OVER LOUVER, LENS, BAFFLE, ETC. TO AVOID FIXTURE SOILING OR DAMAGE. FIXTURES SHALL BE MAINTAINED CLEAN AND AS NEW. ALL LAMPS SHALL BE NEW AT PROJECT COMPLETION - RELAMP EXISTING FIXTURES.
- CONTRACTOR TO VERIFY CODE COMPLIANCE OF EXISTING ACOUSTICAL CEILING GRID SYSTEMS AND ASSOCIATED SEISMIC BRACING RESTRAINTS SYSTEMS FOUND NOT IN COMPLIANCE SHALL BE MODIFIED AND/OR NEW PROVIDED AS REQUIRED BY CURRENT BUILDING CODES (INCLUDING, BU NOT LIMITED TO; CURRENT IBC WALL MOLDING (2" ANGLE) AND SEISMIC SEPARATION JOINTS).
- CONTRACTOR TO VERIFY CODE COMPLIANCE OF ALL EXISTING LIGHTING FIXTURES AND ASSOCIATED SEISMIC BRACING RESTRAINTS. FIXTURES FOUND NOT IN COMPLIANCE SHALL BE MODIFIED AND/OR NEW PROVIDED AS REQUIRED BY CURRENT BUILDING AND/OR ENERGY COMPLIANCE CODES.
- ALL EXITING LIGHTS AND EGRESS LIGHTING LOCATIONS SHALL BE DETERMINED BY BUILDING AND FIRE INSPECTOR'S FIELD PLACEMENT DETERMINATION.
- IMC/IBC OR SUPERCEDING CODE. ALL FIRE DAMPERS SHALL BE INSTALLED IN ACCORDANCE WITH IMC/IBC OR SUPERCEDING CODE.


Finish Notes:

- 1. ALL AREAS TO RECEIVE CARPET AND BASE AS SCHEDULED U.N.O.
- 2. ALL AREAS TO RECEIVE RB-1 U.N.O.
- 3. ALL WALLS & PARTITIONS TO RECEIVE P-1 U.N.O.
- 4. PREP ALL EXISTING FLOOR SURFACES TO RECEIVE NEW FINISHES AS SCHEDULED.
- PROVIDE PAINT APPLICATION APPROPRIATE TO THE SUBSTRATE TO WHICH IT IS TO BE APPLIED.
- ALL EXPOSED GYP. BD. SURFACES, BOTH EXISTING AND NEW, ARE TO RECEIVE NEW PAINT FINISH. PREP ALL SURFACES AS REQUIRED FOR NEW PAINT FINISH. PROVIDE ONE PRIME COAT PLUS TWO FINISH
- CHANGES IN FLOOR MATERIALS THAT OCCUR AT FRAMED DOOR OPENINGS SHALL OCCUR AT THE CENTERLINE OF THE DOOR IN THE CLOSED POSITION.
- ANY DECORATIONS USED SHALL BE NON-COMBUSTIBLE OR FLAME -RETARDANT TREATED IN AN APPROVED OF MANNER (CURTAINS, DRAPES SHADES, HANGINGS, ETC.)
- ALL INTERIOR PARTITIONS, CEILING FINISHES AND TRIM OF PUBLIC AREAS TO COMPLY WITH CLASS 1 MATERIAL CLASSIFICATION: FLAME SPREAD RATING 0 TO 25, SMOKE DEVELOPED 200. ALL INTERIOR WALL AND CEILING FINISHES AND TRIM OF NON-PUBLIC AREAS TO COMPLY WITH CLASS 2 MATERIAL CLASSIFICATION; FLAME SPREAD RATING 26 TO 75, SMOKE DEVELOPED 450.
- 10. FLOOR COVERINGS OF PUBLIC AREAS TO MEET CLASS A INTERIOR FLOOR FINISH REQUIREMENTS; CRITICAL RADIANT FLUX OF 0.45 WATTS PER SQUARE CENTIMETER OR HIGHER, FLOOR COVERINGS OF NON-PUBLIC AREAS TO MEET CLASS B INTERIOR FLOOR FINISH REQUIREMENTS; CRITICAL RADIANT FLUX BETWEEN 0.22 WATTS PER SQUARE CENTIMETER AND 0.44 WATTS PER SQUARE CENTIMETER.
- CARPET INSTALLATION TO MEET THE GUIDELINES OF THE CARPET AND RUG INSTITUE—"STANDARD FOR INSTALLATION SPECIFICATION OF COMMERCIAL CARPET", CRI 104 - 2002 EDITION.
- PROVIDE FINISHED SCRIBE STRIPS AND FINISHED MILLWORK EDGES TO CREATE A FINISHED REVEAL CONDITION WHERE MILLWORK COUNTERS. CABINETS, ETC. ABUT ADJACENT PARTITION CONSTRUCTION. ALL EXPOSED REVEAL SURFACES AND EDGES TO HAVE SAME PLASTIC LAMINATE FINISH AS THE CASEWORK ITEM THEY ABUT.

CONSULTING GROUP, INC.

Carillon Point B3000 Floor 5 3500 Carillon Point Kirkland, WA 98033

DESIGN JPC DRAWN SG/AN CHECKED CP/AN NO. 12-0309

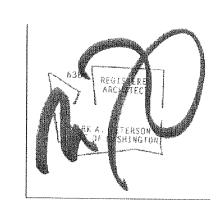


04/27/12 Permit Set

General Notes &

Carillon Point B3000 Floor 5 3500 Carillon Point Kirkland, WA 98033

DESIGN DRAWN SG/AN CHECKED CP/AN NO. 12-0309

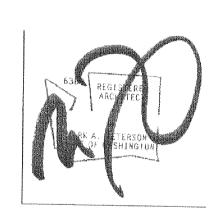


04/27/12 Permit Set

Code Summary

I-CS-1

© 2011, JPC Architects, PLLC

Legend: "COMMON PATH OF EGRESS TRAVEL" IS LESS THAN 100'-0" AS ALLOWED FOR SPRINKLERED BUILDINGS WITH QUICK RESPONSE HEADS, PER 2006 IBC 1014.3, EXCEPTION #1. "TOTAL EXIT ACCESS TRAVEL DISTANCE" IS LESS THAN 300'-0" AS ALLOWED FOR SPRINKLERED BUILDINGS WITH QUICK RESPONSE HEADS. Exit Plan
Scale: 1/8"=1'-0"

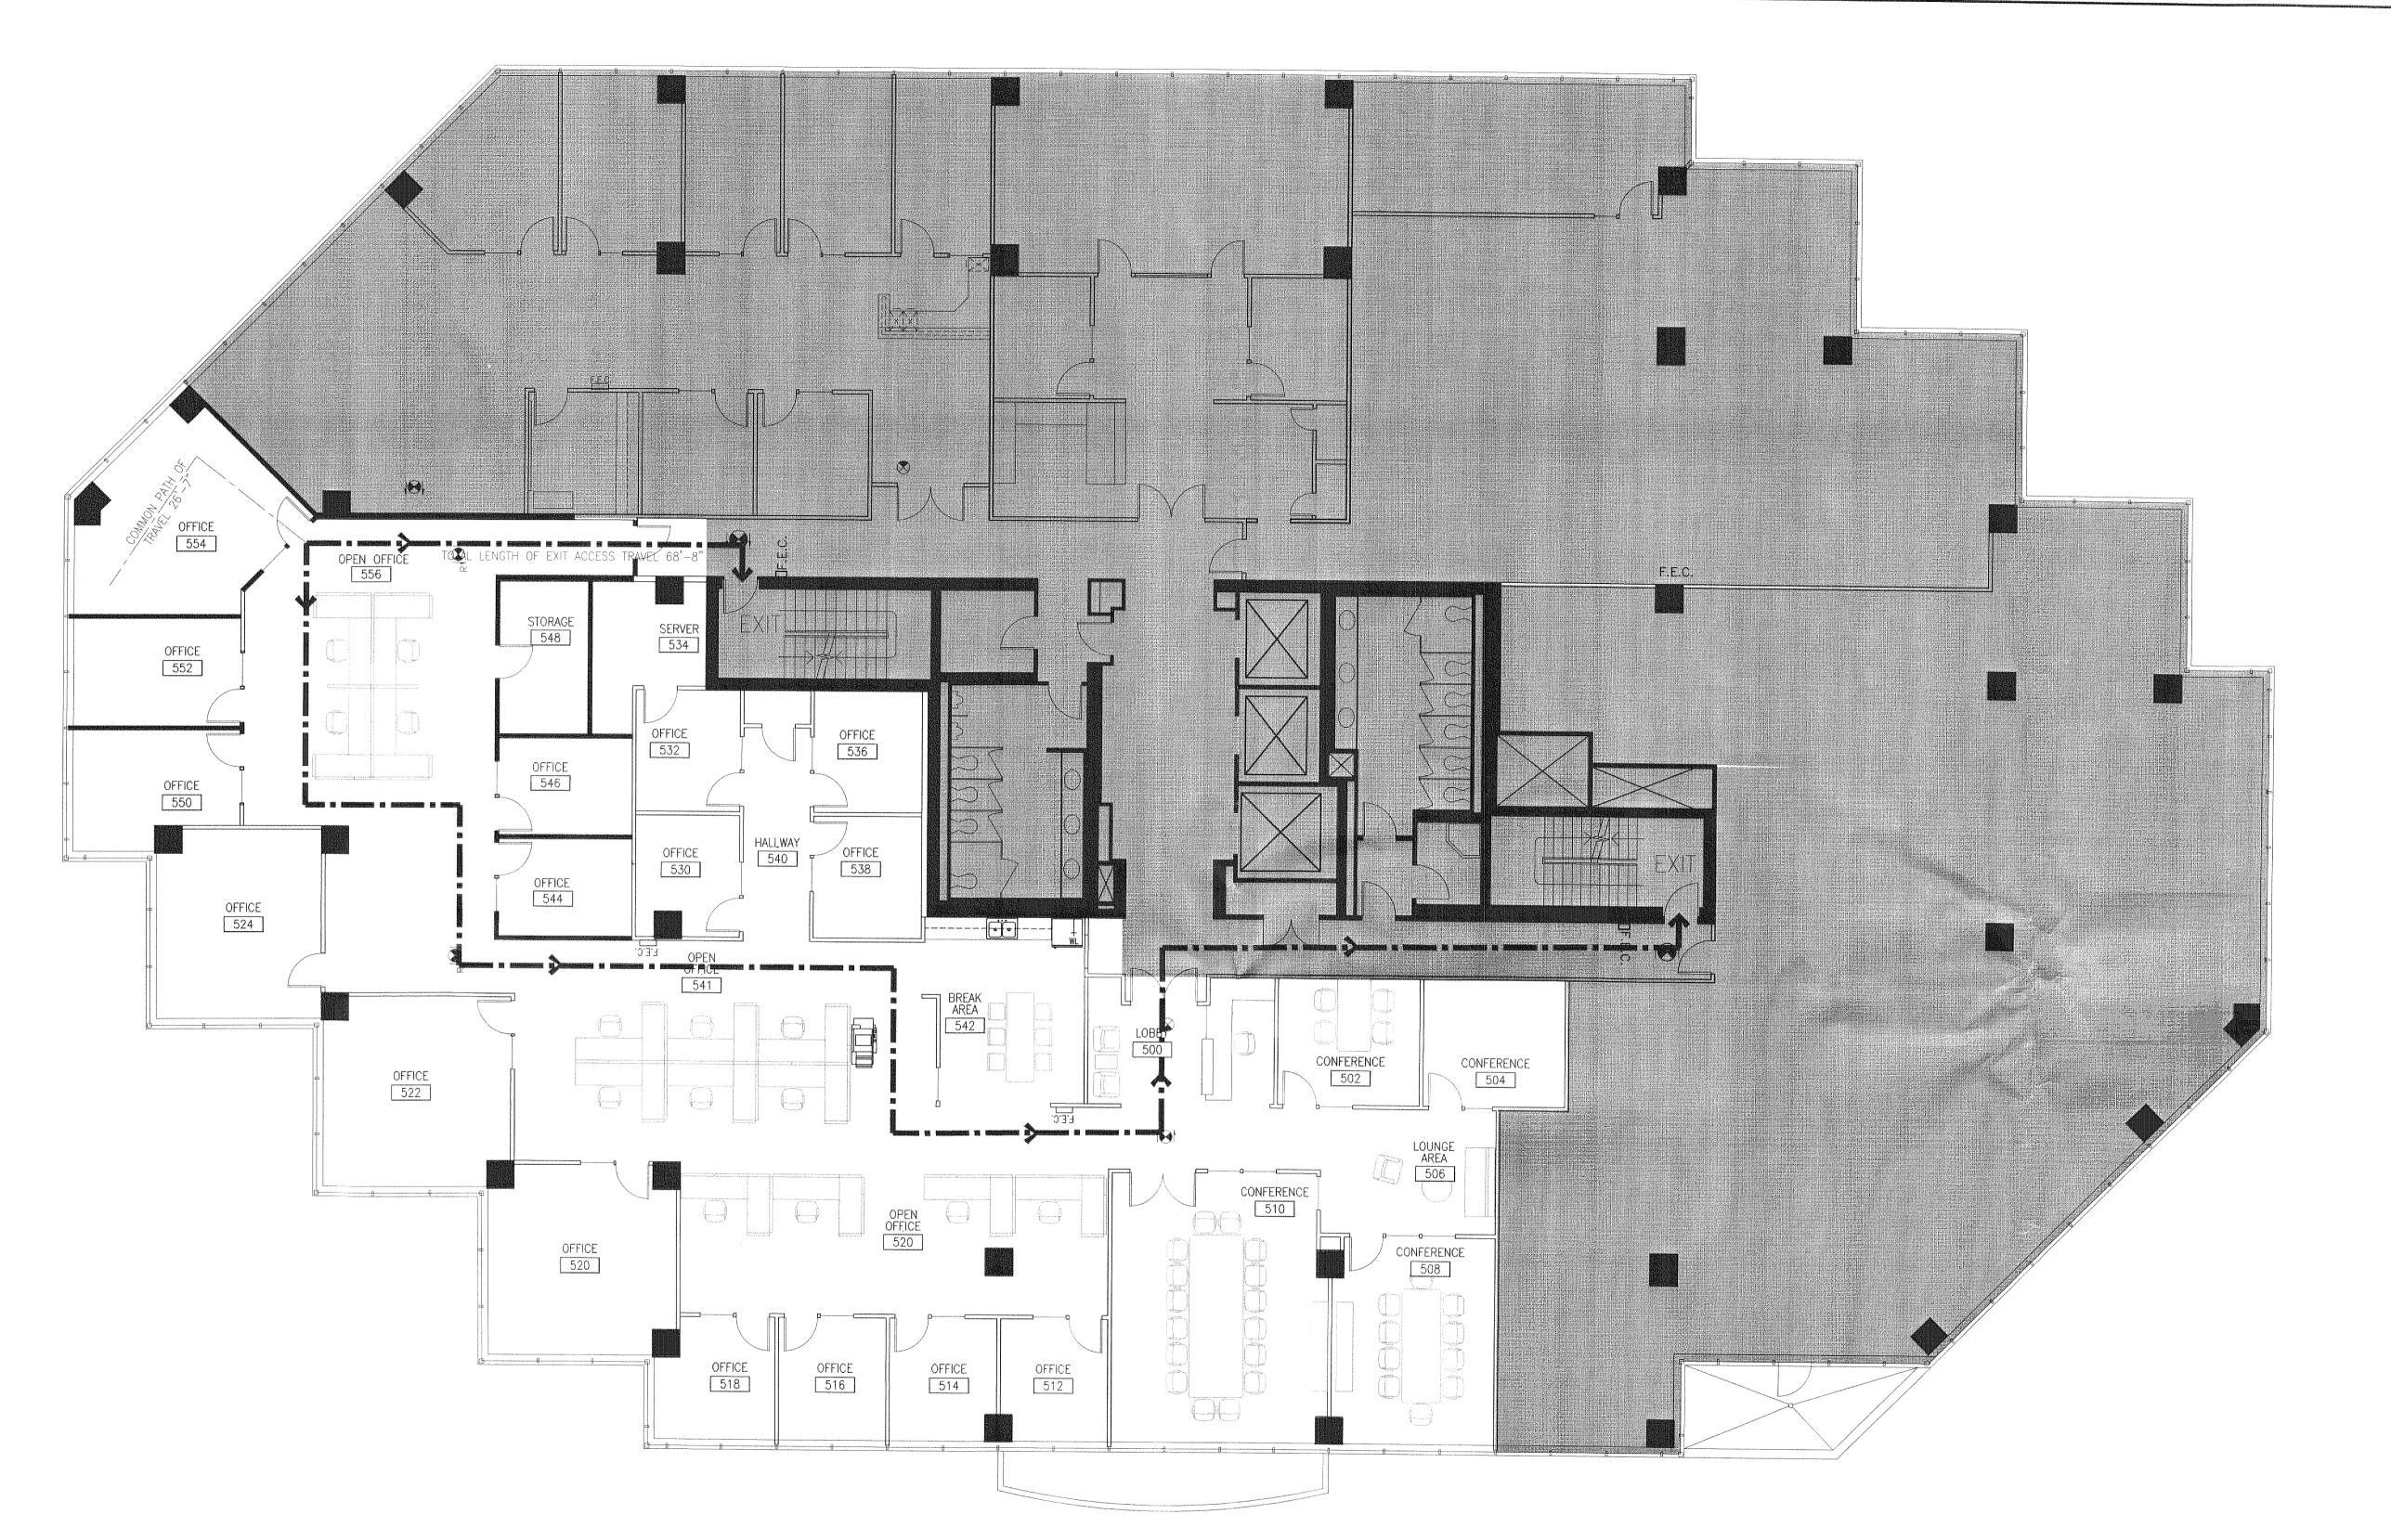

Partition Legend:

EXISTING PARTITION/CONSTRUCTION TO REMAIN

= = EXISTING PARTITION/CONSTRUCTION TO BE REMOVED


Demolition Key Notes:

- EXISTING FINISH FLOORING & BASE TO BE DEMOLISHED THROUGHOUT SCOPE OF WORK. PATCH AND REPAIR AFFECTED SUBSTRATE AS RQD. FOR INSTALLATION OF NEW FLOORING AND BASE MATERIALS. REFER TO FLOOR PLAN FOR ADDITIONAL INFORMATION.
- REMOVE THE EXISTING FLOOR ELECTRICAL/DATA OUTLET. REFER TO NOTE

XTREME CONSULTING GROUP, INC.

Carillon Point B3000 Floor 5 3500 Carillon Point Kirkland, WA 98033

DESIGN JPC DRAWN SG/AN CHECKED CP/AN 12-0309

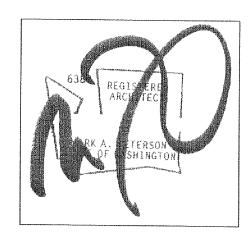

04/27/1	2	Perr	nit	S

Demolition Plan

I-1.5

Demolition Plan


Scale: 1/8"=1'-0"

THY THE

TYPICAL THROUGHOUT

± = - - - - - - - q

SCOPE OF WORK

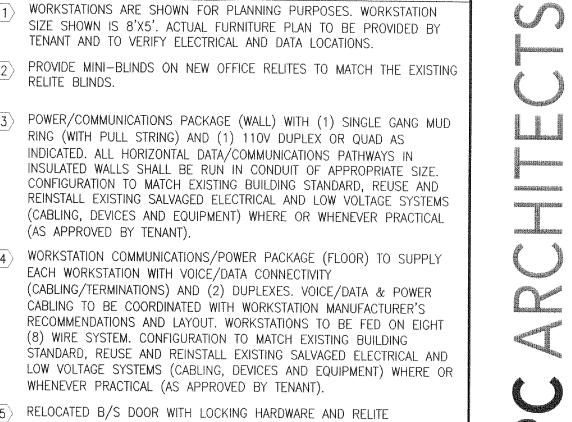

EXISTING PARTITION/CONSTRUCTION TO REMAIN

FOURPLEX RECEPTACLE

→ SPECIAL RECEPTACLE

CORE DRILL

Floor Plan
Scale: 1/8"=1'-0"

DEDICATED FOURPLEX RECEPTACLE

BASE POWER FOR TENANT PROVIDED SYSTEMS FURNITURE.

NO DESIGNATION OR E = EXISTING

VOICE/DATA RECEPTACLE. CONTRACTOR TO PROVIDE MUD RING AND PULL STRING

CR— CARD READER

N = NEW &/OR RELOCATED (COORDINATE

RELOCATED ITEMS W/ARCHITECT)

GRID HEIGHT PARTITION. REFER TO DETAIL 2/I-9.1.

Key Notes:

XTREME CONSULTING GROUP, INC.

Carillon Point B3000 Floor 5 3500 Carillon Point Kirkland, WA 98033


DESIGN JPC DRAWN CHECKED NO.

SG/AN CP/AN 12-0309


04/27/12 Permit Set

Floor Plan

1-3.5

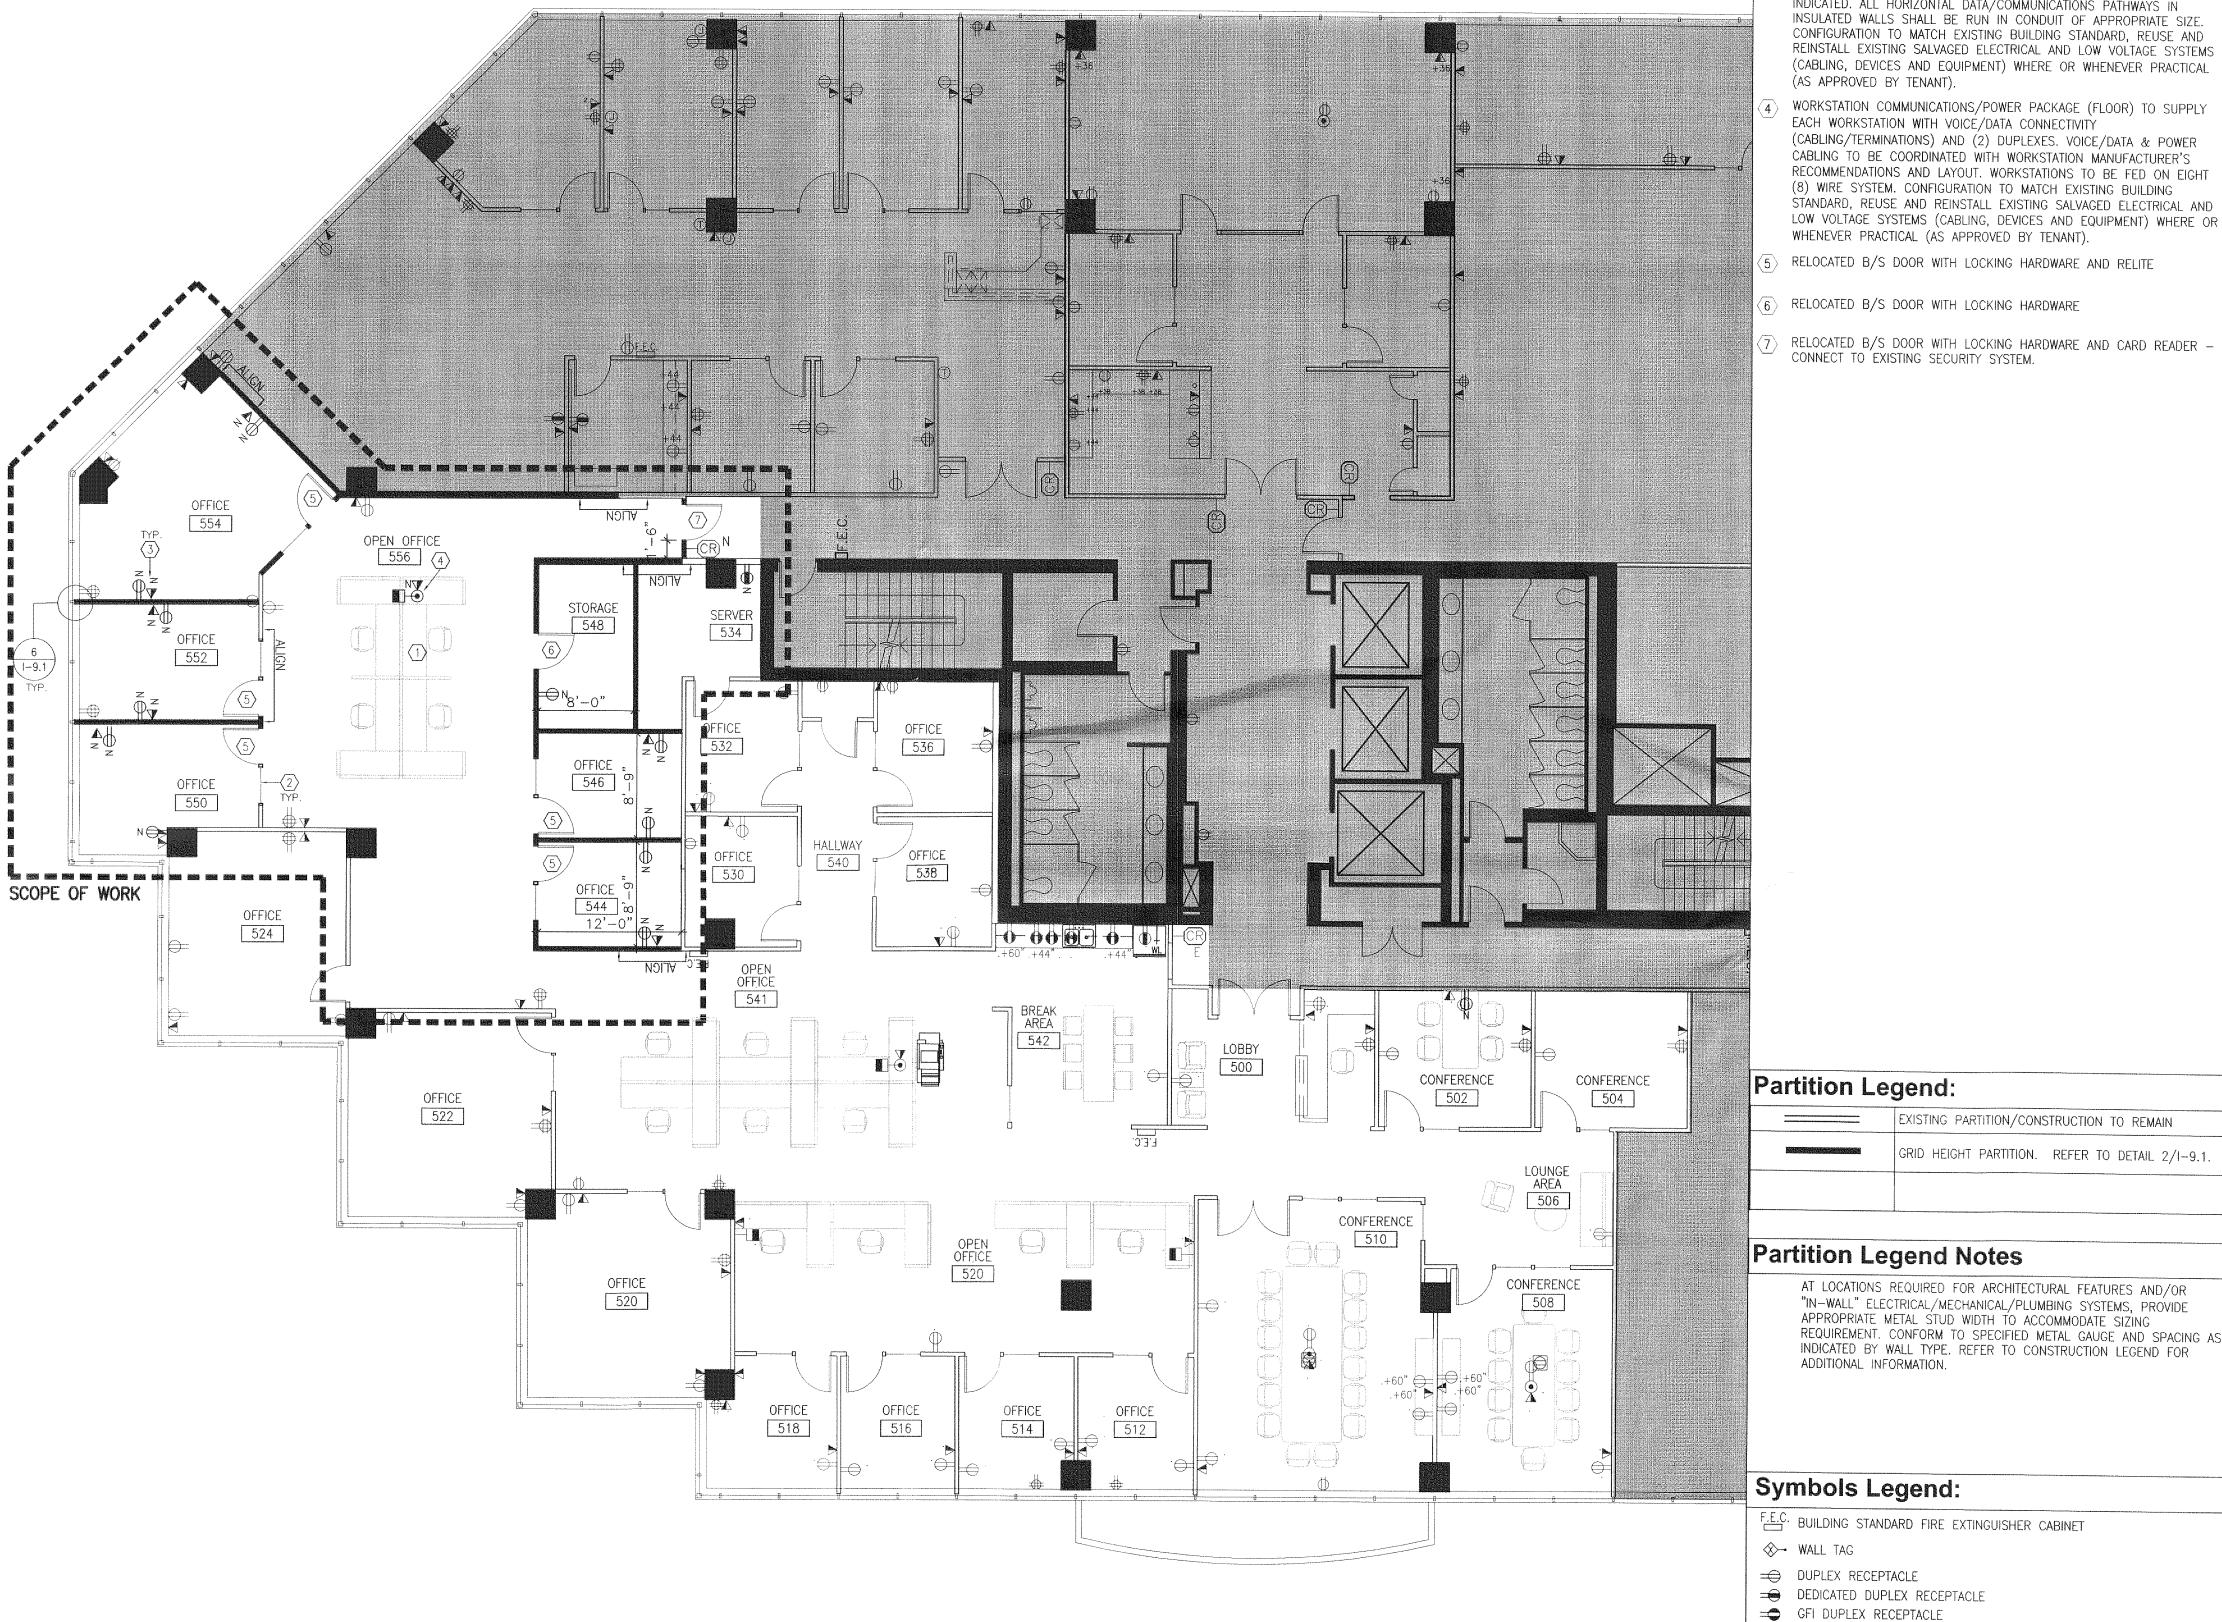

Reflected Ceiling Demolition Plan

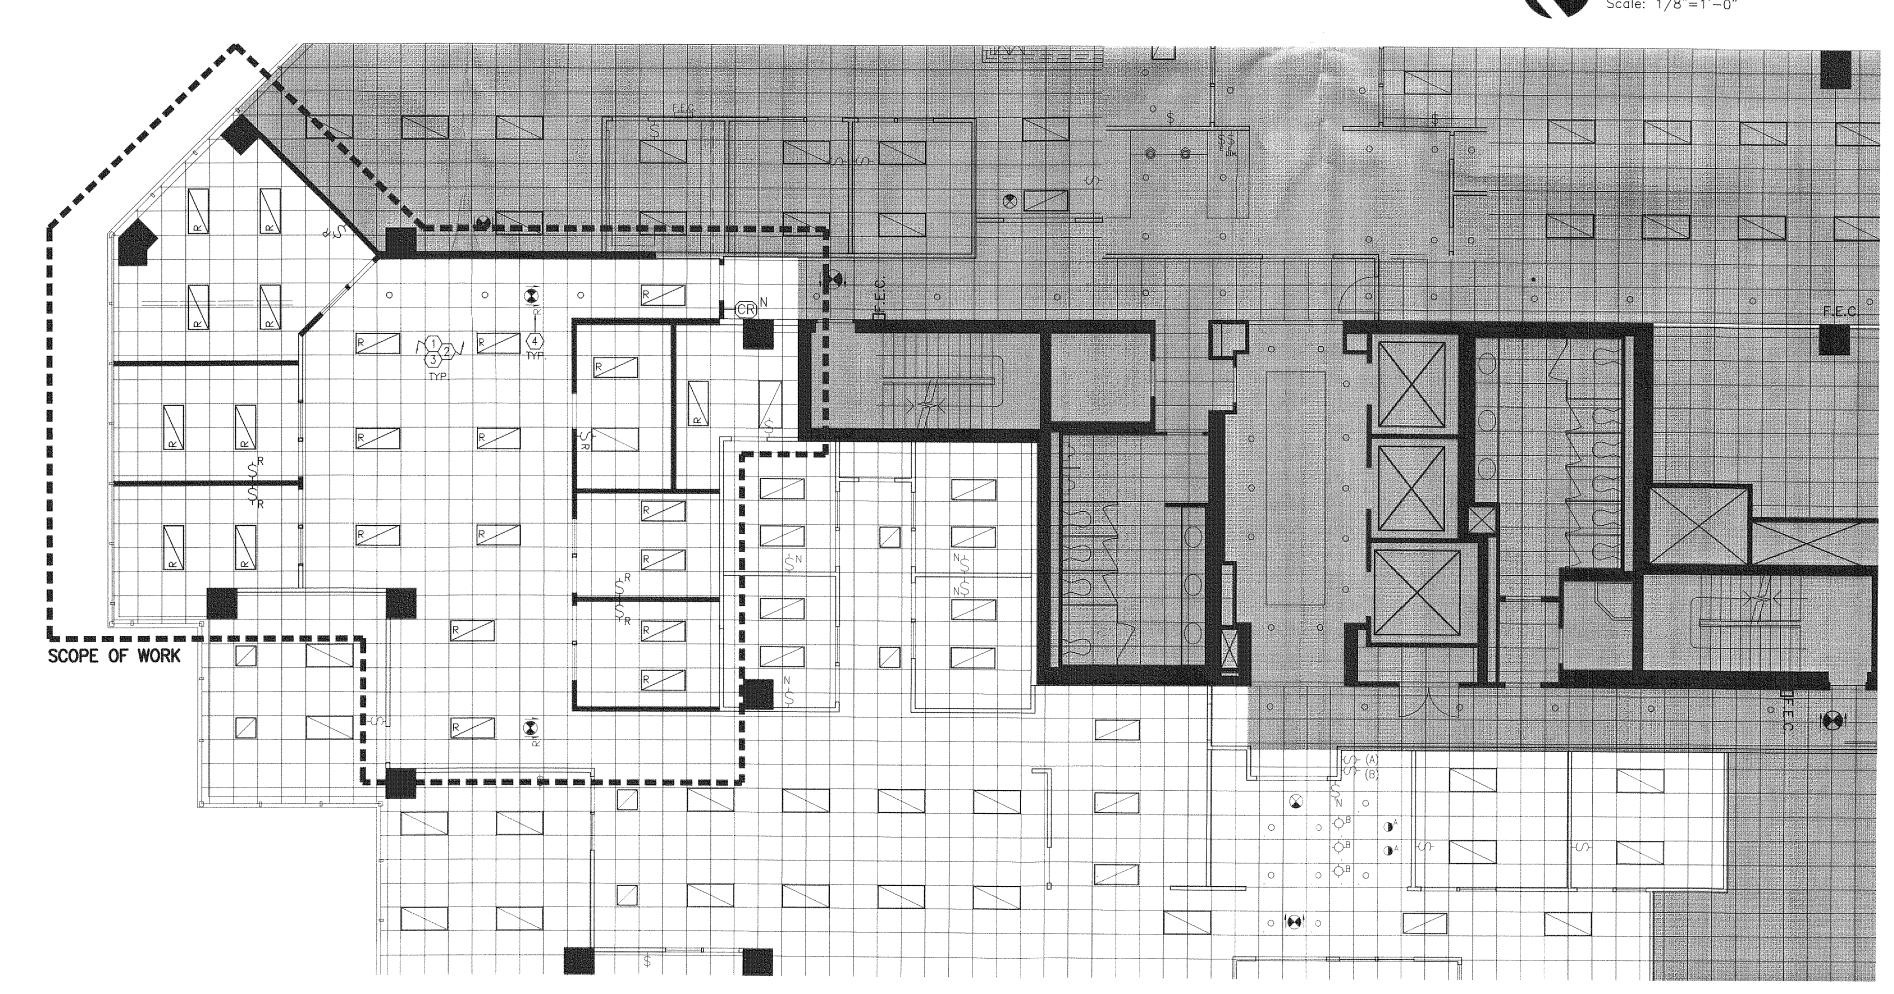

Demolition RCP Key Notes:

XTREME CONSULTING GROUP, INC.

Carillon Point B3000 Floor 5 3500 Carillon Point Kirkland, WA 98033

DESIGN DRAWN SG/AN CHECKED CP/AN 12-0309

RCP Key Notes:

- MODIFY EXISTING ELECTRICAL, MECHANICAL AND LIFE SAFETY SYSTEMS AS REQUIRED TO ACCOMMODATE NEW SUITE DEMISING AND INTERIOR BUILD OUT, INCLUDING, BUT NOT LIMITED TO CIRCUITING, SWITCHING, DUCTING (SUPPLIES/RETURNS), ZONING AND BALANCING AND/OR HORN/STROBE RELOCATION. PROVIDE NEW B/S EMERGENCY LIGHTING ("BUG EYES") AS PER CURRENT CODE REQUIREMENTS.
- EXISTING BUILDING STANDARD SUSPENDED CEILING GRID AND ACOUSTICAL TILE SYSTEM. REPLACE ALL DAMAGED AND/OR STAINED TILE WITHIN SCOPE OF NEW WORK. REPLACE EXISTING LIGHT FIXTURES WITH NEW B/S FOCAL POINT LUNA. REFER TO SYMBOLS LEGEND AND GENERAL NOTES FOR ADDITIONAL INFORMATION.
- RECONFIGURE SWITCHING TO CONFORM TO NEW LAYOUT. CONFIRM CONTROL PROGRAMMING WITH TENANT. MASTER SUITE SWITCH FOR COMMON AREAS. VERIFY WITH TENANT.
- ILLUMINATED EXIT LIGHTING. ALL EXIT LIGHTS AND EGRESS LIGHTING LOCATIONS SHALL BE DETERMINED BY BUILDING AND FIRE INSPECTOR'S FIELD PLACEMENT DETERMINATION.


			
Symk	ools Lege	nd	
TYPE	SYMBOL	MFG.	DESCRIPTION
	\$		SWITCH
	\$3		3WAY SWITCH
	1001		BLDG STD EXIT LIGHT
	++		EXTG BLDG STD 2x2 SUSP. CEILING GRID
F-1		FOCAL POINT LUNA	NEW BLDG STD. 2x4 FLU. LIGHT FIXTURE
F-2		FOCAL POINT LUNA	NEW BLDG STD. 2x2 FLU. LIGHT FIXTURE
F-3	0		BLDG STD. RECESSED FLU. DOWNLIGHT FIXTURE

D = DEMOLISH

Reflected Ceiling Plan

04/27/12 Permit Set

1-4.5

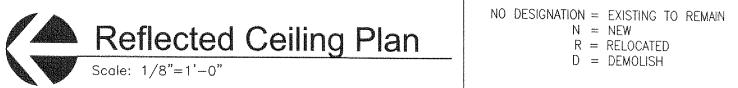

MFR REP.: LAURIE STALEY #206-275-4980

Finish Specifications

TYPICAL FLOORING, U.N.O.

MFR: SHAW

STYLE NAME: DIVIDE 5A065

COLOR NO: 65585 COLOR NAME: CAST IRON INSTALLATION: ROLL OVER PAD

VCT VINYL COMPOSITION TILE

MFR: MANNINGTON TI

COLOR NO: 712

MFR: MANNINGTON COMMERCIAL

VCT VINYL COMPOSITION TILE

MFR: MANNINGTON COMMERCIAL

SERIES: BRUSHWORK

COLOR NAME: BLACK-BROWN

GENERAL WALL PAINT (TYPICAL U.N.O.)

SHEEN: EGGSHELL, SEMI-GLOSS @ WET AREAS

P MFR: SHERWIN WILLIAMS
COLOR NAME: PANDA WHITE

COLOR NO: SW6147

P MFR: SHERWIN WILLIAMS 2 COLOR NAME: WOOL SKEIN

COLOR NO: SW6148

SHEEN: EGGSHELL

P MFR: SHERWIN WILLIAMS
COLOR NAME: BUNGLEHOUSE GRAY COLOR NO: SW2845

SHEEN: SATIN

4 COLOR NAME: GRANITE PEAK

SHEEN: SATIN

Key Notes:

1 NEW CARPET AND RUBBER BASE THROUGH-OUT SCOPE OF WORK UNLESS NOTED OTHERWISE. PROVIDE ROLL CARPET OVER PAD.

TOUCH UP COMMON HALLWAY FINISHES AS NECESSARY DUE TO SCOPE OF WORK.

COLOR NO: SW6250

P MFR: SHERWIN WILLIAMS


COLOR NO: 193 PROFILE: 4" COVE

FLOORING

XTREME CONSULTING GROUP, INC.

Carillon Point B3000 Floor 5 3500 Carillon Point Kirkland, WA 98033

DESIGN JPC DRAWN SG/AN CHECKED CP/AN 12-0309

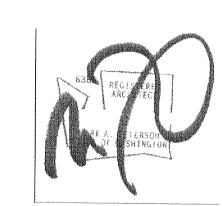

04/27/12	Permit Set

Finish Plan & Finish Specifications

1-6.5

© 2011, JPC Architects, PLLC

Finish Plan
Scale: 1/8"=1'-0"

COMPOSITE DESIGN FOR STEEL STUD PARTITIONS

STANDARD GAGE (25) STUDS		20 GAGE STUDS			
STUD WIDTH	STUD SPACING	ONE LAYER EACH SIDE	STUD WIDTH	STUD SPACING	ONE LAYER EACH SIDE
2 1/2"	16"	12'-0"	2 1/2"	16"	13'-0"
	24"	10'-6"		24"	11'-5"
3 5/8"	16"	15'-8"	3 5/8"	16"	17'-4"
	24"	13'-4"		24"	15'-2"
4"	16"	16'-10"	4"	16"	18'-7"
	24"	13'-11"		24"	16'-2"
6"	16"	19'-4"	6"	16"	25'-7"
	24"	15'-6"		24"	21'-11"

NOTES:


-ASSUMED ALLOWABLE DEFLECTION = L/240
-PROVIDE STUD BRIDGING AS REQUIRED BY
GOVERNING CODES AND REGULATIONS

Drywall Studs Limiting Heights

—— SHIM AS REQ'D, SECURE TO GRID - INSULATION TO EXTEND 2'-0" BEYOND EACH SIDE OF WALL AS NOTED BELOW - CEILING AS SPECIFIED PAINT REVEAL FLAT BLACK OR TAPED BLACK (MATCH EXIST. CONDITION) - INSULATION AS NOTED BELOW ONE LAYER 5/8" GWB EACH SIDE OF WALL -MTL. STUDS - WIDTH, GA. & SPACING AS NOTED BELOW - CONT. MTL. RUNNER MECHANICALLY FASTENED TO SUBFLOOR WITH STEEL NAILS EVERY 24" O.C. WITH AN EMBED. DEPTH OF 1/2" — SPECIFIED BASE - FINISHED FLOOR -1/8" FOAM TAPE

WALL	STUD SIZE	STUD GAUGE	STUD SPACING	WALL	INSUL	ATION	FIRE RATING/ UL DESIGN NO.	COMMENTS
TYPE	GIOD GILL	3100 01001	3100 SI AGING TH	THICKNESS	WALL	CEILING		
Α	2 1/2"	25 GAUGE	24" O.C.	3 3/4"	SB	SB		REF. 8/I-9.1 FOR BRACING
		Manan		******	_	_	ervein.	, no constant of the constant
					*SB=SOU	ND ATTEN	UATION BATTS	FR=FIRE RESISTIV


(2) Grid Ht. Partition

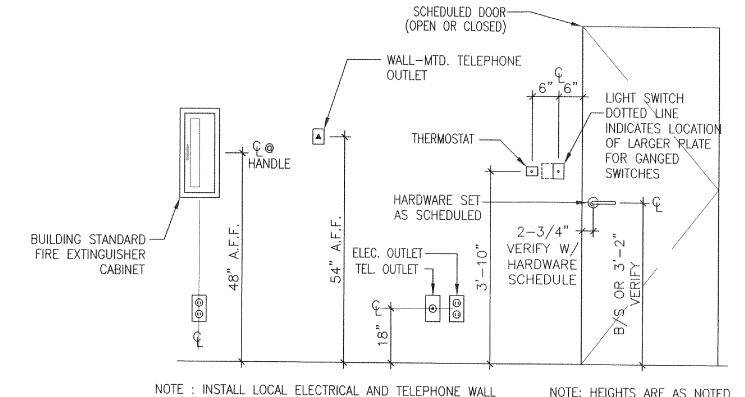

NOTE: INSTALL LOCAL ELECTRICAL AND TELEPHONE WALL
OUTLETS AND SWITCHPLATES AT NEAREST STUD FROM SCALED
LOCATION ON PLAN UNLESS SPECIFICALLY DIMENSIONED.

NOTE: HEIGHTS ARE AS NOTED
UNLESS DIRECTED BY B/S TO
BE DIFFERENT

4 Typical Mounting Heights

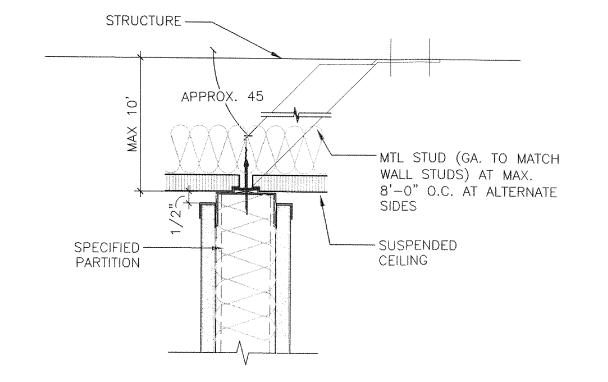

8 Partition Bracing Detail

VINYL COMP. TILE OR EXPOSED CONCRETE


RUBBER REDUCER STRIP

TACKSTRIP

CARPET, OVER PAD

- CONCRETE FLOOR

5 VCT to Carpet Transition

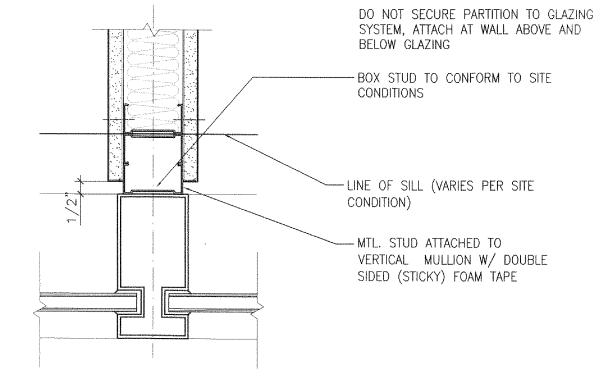

6 Typical Mullion/Partition Intersection

7 Not Used

| Scale: 3/8"=1'-0"

Not Used

Scale: 3"=1'-0"

REGISTERE ARCHITECT

XTREME

CONSULTING GROUP, INC.

Carillon Point B3000

3500 Carillon Point

Kirkland, WA 98033

JPC

SG/AN

CP/AN

12-0309

Floor 5

DESIGN

DRAWN

NO.

CHECKED

04/27/12 Permit Set

Construction Details & Elevations

1-9.1

CITY OF KIRKLAND
APPROVED FOR SUBMITTAL Type of Review Mittals / Date Exp FT Reg

HOURS OF WORK: 7AM TO 8PM MON-FRI DAM TO 6PM SAT. NO WORK SUNDAYS & HOLIDAYS (PER KZC SEC. 115.25) Exceptions must be approved in writing by Planning Official

BUILDI
PERMIT # BNR12-00683 CITY OF KIRKLAND BUILDING DEPARTMENT

ADDRESS 3500 CARILLON PT
WORK CLASS INTERIOR ALTERATION
PROJECT
OWNER CARILLON PROPERTIES
DT SUBMITTED 04/27/2012
DT APPROVED APPROVED BY

PERMIT IS RECUIRED